

LOT MISCLOSE 0.000 m

A DISCLAIMER: Due to lack of survey marks/pegs, all building offset dimensions & features are approximate only and positioned from existing pegs/fences and walls which may not be on the correct alignment. Any design that involves additions to any structures shown or portion of structures remaining after any demolition has taken place requires boundaries to be repegged and exact offsets provided to your designer/carchitect before any plans are produced. designer/architect before any plans are produced and before any work is started on site. A DISCLAIMER:

Lot boundaries drawn on survey are based on landgate plan only. Survey does not include title search and as such may not show easements or other interests not shown on plan. Title should be checked to verify all lot details and for any easements or other interests which may affect building on the property.

▲ DISCLAIMER: Survey does not include verification of cadastral boundaries. All features and levels shown are based on orientation to existing pegs and fences only which may not be on correct cadastral alignmen Any designs based or dependent on the location of existing features should have those features' location verified in relation to the true boundary.

▲ DISCLAIMER:
Survey shows visible features only and will not show locations of underground pipes or conduits for internal or mains services. Verification of the location of all internal and mains services should be confirmed prior to finalisation of any

▲ DISCLAIMER:
Cottage & Engineering surveys accept no responsibility for any physical on site changes to the parcel or portion of the parcel of land shown on this survey including any adjoining neighbours levels and features that have occurred after the date on this survey. All Sewer details plotted from information supplied by Water Corporation.

Osborne Park

Osborne Park, WA 6017 SURVEYS

P: (08) 9446 7361
E: perth@cottage.com.au
W: www.cottage.com.au
W: www.cottage.com.au

SUBURB Sorrento LGA DRAWN T.Currey


JOB# 542529 CITY OF JOONDALUP AREA 711m<sup>2</sup> VOL. 1482 FOL. 905 DATE 07 Mar 23


ELEC. O/Head GPS Lat: -31.836189 Long: 115.751757 ROADS Bitumen KERBS Mountable / Nil COMMS. Yes FOOTPATH Nil WATER Yes SOIL GAS Check Alinta Sand, L'Stone(Poss) SEWER Yes DRAINAGE Good COASTAL 250m To Ocean (Approximate Only Confirm With Shire) VEGETATION Refer to Survey SSA No

E nick@ndpdesign.com.au W ndpdesign.com.au M 0414 592 142 SITE PLAN SCALE 1:100 © Copyright CLIENT: ADDRESS: HEUER LOT 254 (# 19) HIGH STREET, SORRENTO Contractors must check all dimensions, levels and gradients before commencing any work or preparing any shop drawings. Contractors shall worked to figured dimensions. Large scale drawings preferred to small scaled drawings. Report any discrepancies to the Designer THIS DRAWING IS THE COPYRIGHT OF NDP DESIGN AND MUST NOT BE RETAINED, USED, COPIED OR REPRODUCED IN ANY FORM, IN PART OR IN WHOLE, WITHOUT PRIOR for direction or clarification before proceeding with the work. All architectural drawings to be read in conjunction with all or any consultant drawings.

WRITTEN AUTHORITY FROM NDP DESIGN.

DRAWN: 16-10-23 PLANNING ISSUE AZ119 SEPT. 2023 SHEET SIZE:

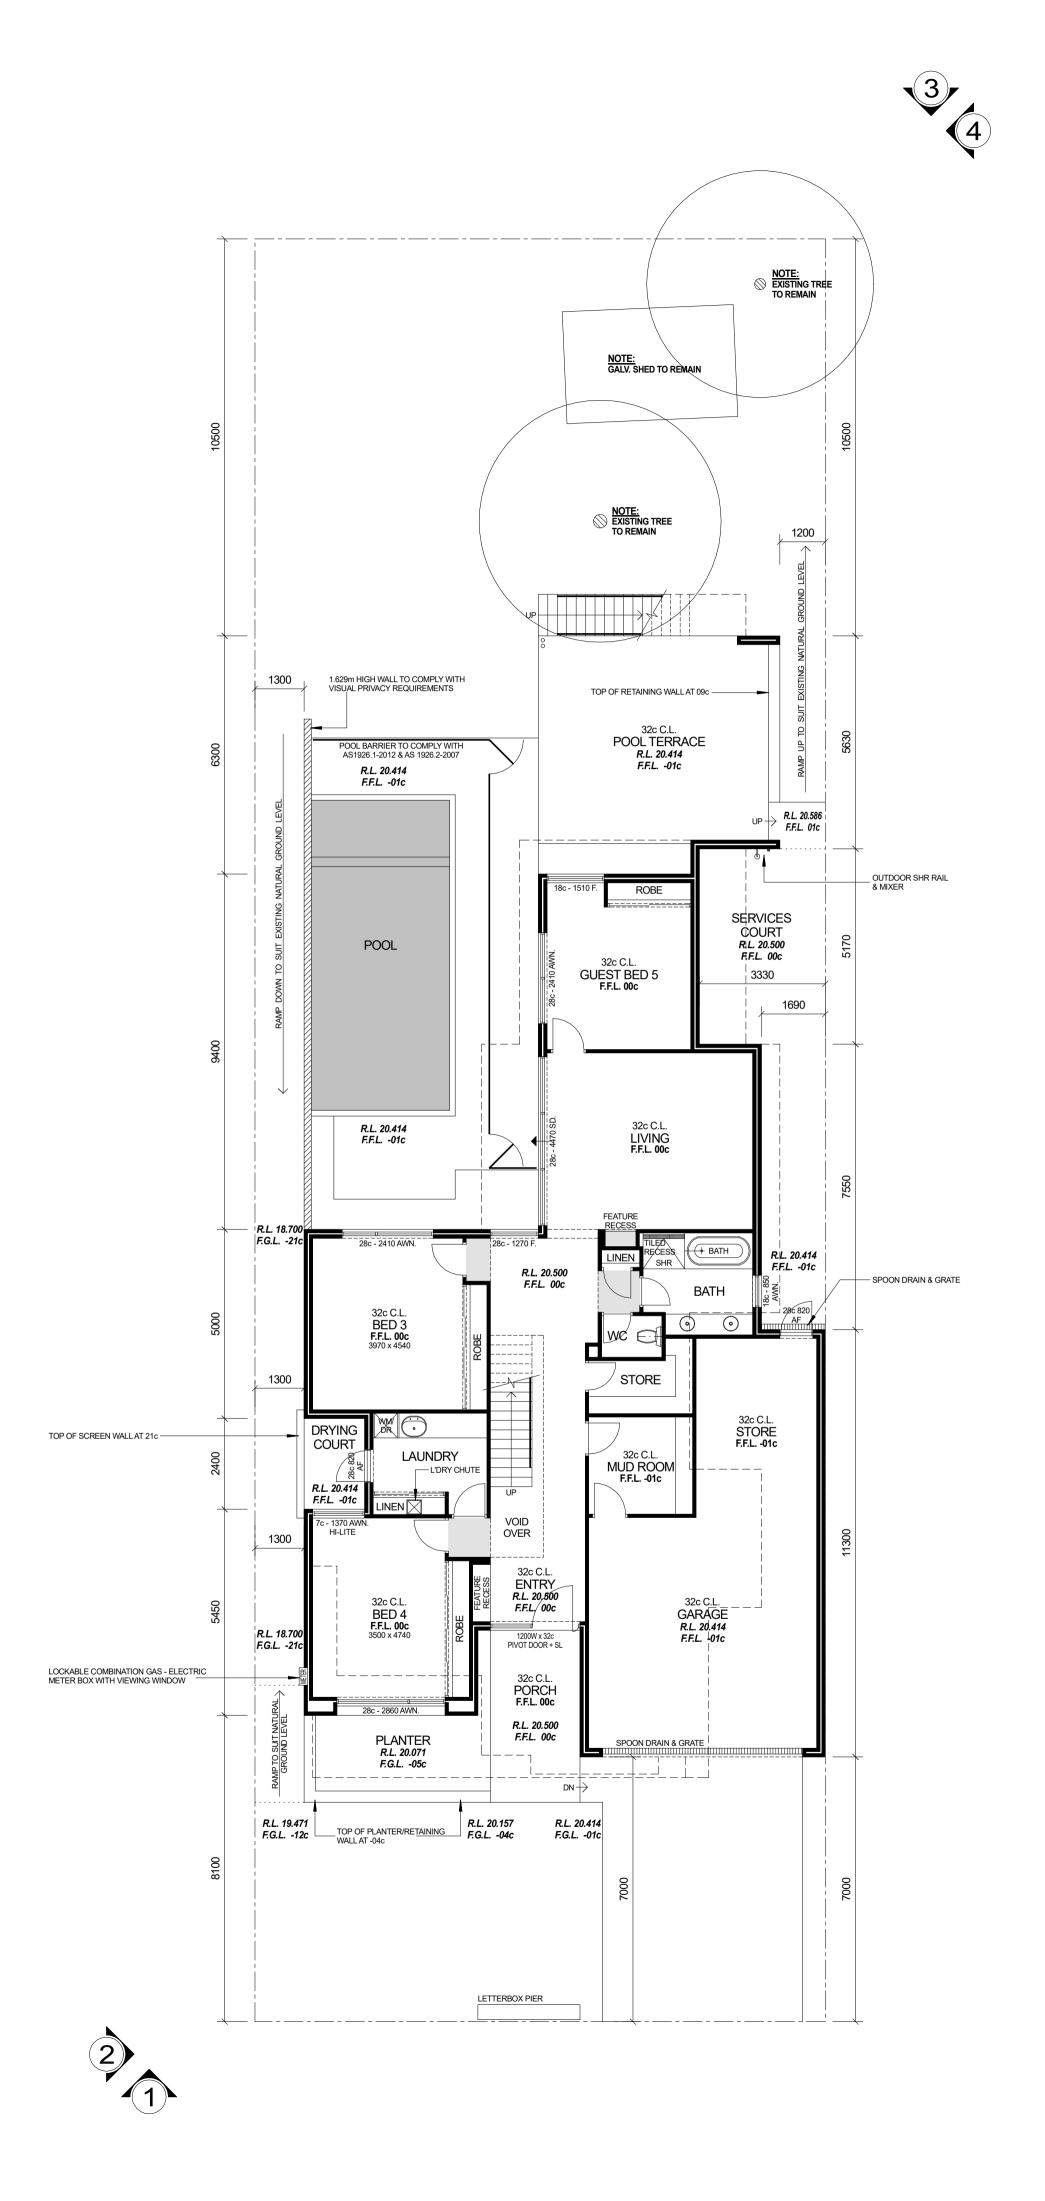

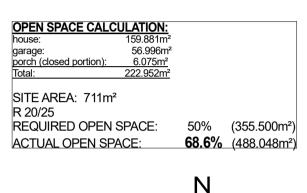



SYM	<b>I</b> BOL	DESCRIPTION	No. OFF
R	/A	CEILING FRAME NOTE: BOX OUT CEILING JOISTS 1200 x 600 FOR A/C RETURN AIR - PROVIDE UNRESTRICTED ACCESS OVER	0 OFF
М	<b>VH</b>	CEILING FRAME NOTE: 450x450 MAN HOLE INTO ROOF SPACE - PROVIDE UNRESTRICTED ACCESS OVER	0 OFF
[_ <b>A</b> /	C1	CEILING FRAME NOTE: BOX OUT CEILING JOISTS 1050 x 250 FOR A/C LINEAR VENTS - PROVIDE UNRESTRICTED ACCESS OVER	0 OFF
<i>W</i> /	P 1	BRICKLAYER NOTE: 810 WIDE x 110 HIGH OPENING IN BRICKWORK (FROM 2230 TO 2340 - HEIGHT NOTED ABOVE +06c OFFICE F.L.	0 OFF
Š	SQ	HARD WIRED SMOKE DETECTOR	SEE PLAN
(§	3)	SILICONE JOINT TO CORNER WINDOW - MITRED GLASS TO CORNER	SEE PLAN
NOT	E.		

NOTE:
-ALL EXTERNAL DOORS TO HAVE WEATHER SEALS.
-ALL ALUMINIUM WINDOWS TO COMPLY WITH AS 2047.
- CHIMNEY FLUES TO HAVE DAMPERS FITTED.
- EXHAUST FANS AND RANGEHOODS TO HAVE DAMPERS FITTED.
- STAIR CONSTRUCTION TO COMPLY WITH BCA STANDARDS (Part 3.9.1.).
- SELECTED BALUSTRADE TO COMPLY WITH BCA STANDARDS (Part 3.9.2).
- NUMBER & POSITION OF DOWNPIPES ARE SUBJECT TO VARIATION BY PLUMBER ON SITE.
- THESE DRAWINGS ARE TO BE READ IN CONJUNCTION WITH STRUCTURAL ENGINEERS DWGS.
- LIFT OFF HINGES ARE TO BE USED TO ALL WC'S TO COMPLY WITH BCA STANDARDS (Part 3.8.3.3).
- ALL WINDOW OPENINGS TO COMPLY WITH BCA STANDARDS (Part 3.9.2.5).

NOTE:
WIND RATING N APPLIES

 GROUND FLOOR AREA:

 house:
 159.881m²
 (per. 71.400m)

 garage:
 56.996m²

 pool terrace:
 38.830m²

 porch:
 9.045m²

Total ground floor: 264.752m²

 1st FLOOR AREA:

 house:
 216.241m²
 (per. 78.380m)

 balcony 1:
 10.473m²

 balcony 2:
 36.352m²

Total 1st floor area: 263.066m²

TOTAL AREA: 527.818m²





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SCALE 1:100


CLIENT:
HEUER
ADDRESS:
LOT 254 (# 19)
HIGH STREET,
SORRENTO

Contractors must check all dimensions, levels and gradients before commencing any work or preparing any shop drawings. Contractors shall worked to figured dimensions. Large scale drawings preferred to small scaled drawings. Report any discrepancies to the Designer for direction or clarification before proceeding with the work. All architectural drawings to be read in conjunction with all or any consultant drawings.

DATE REVISION DATE REVISION DATE REVISION DRAWN: JOB NO: NDP

REVISION DATE REVISION DRAWN: NDP DATE: SEPT. 2023

SHEET SIZE: SHEET 2 4

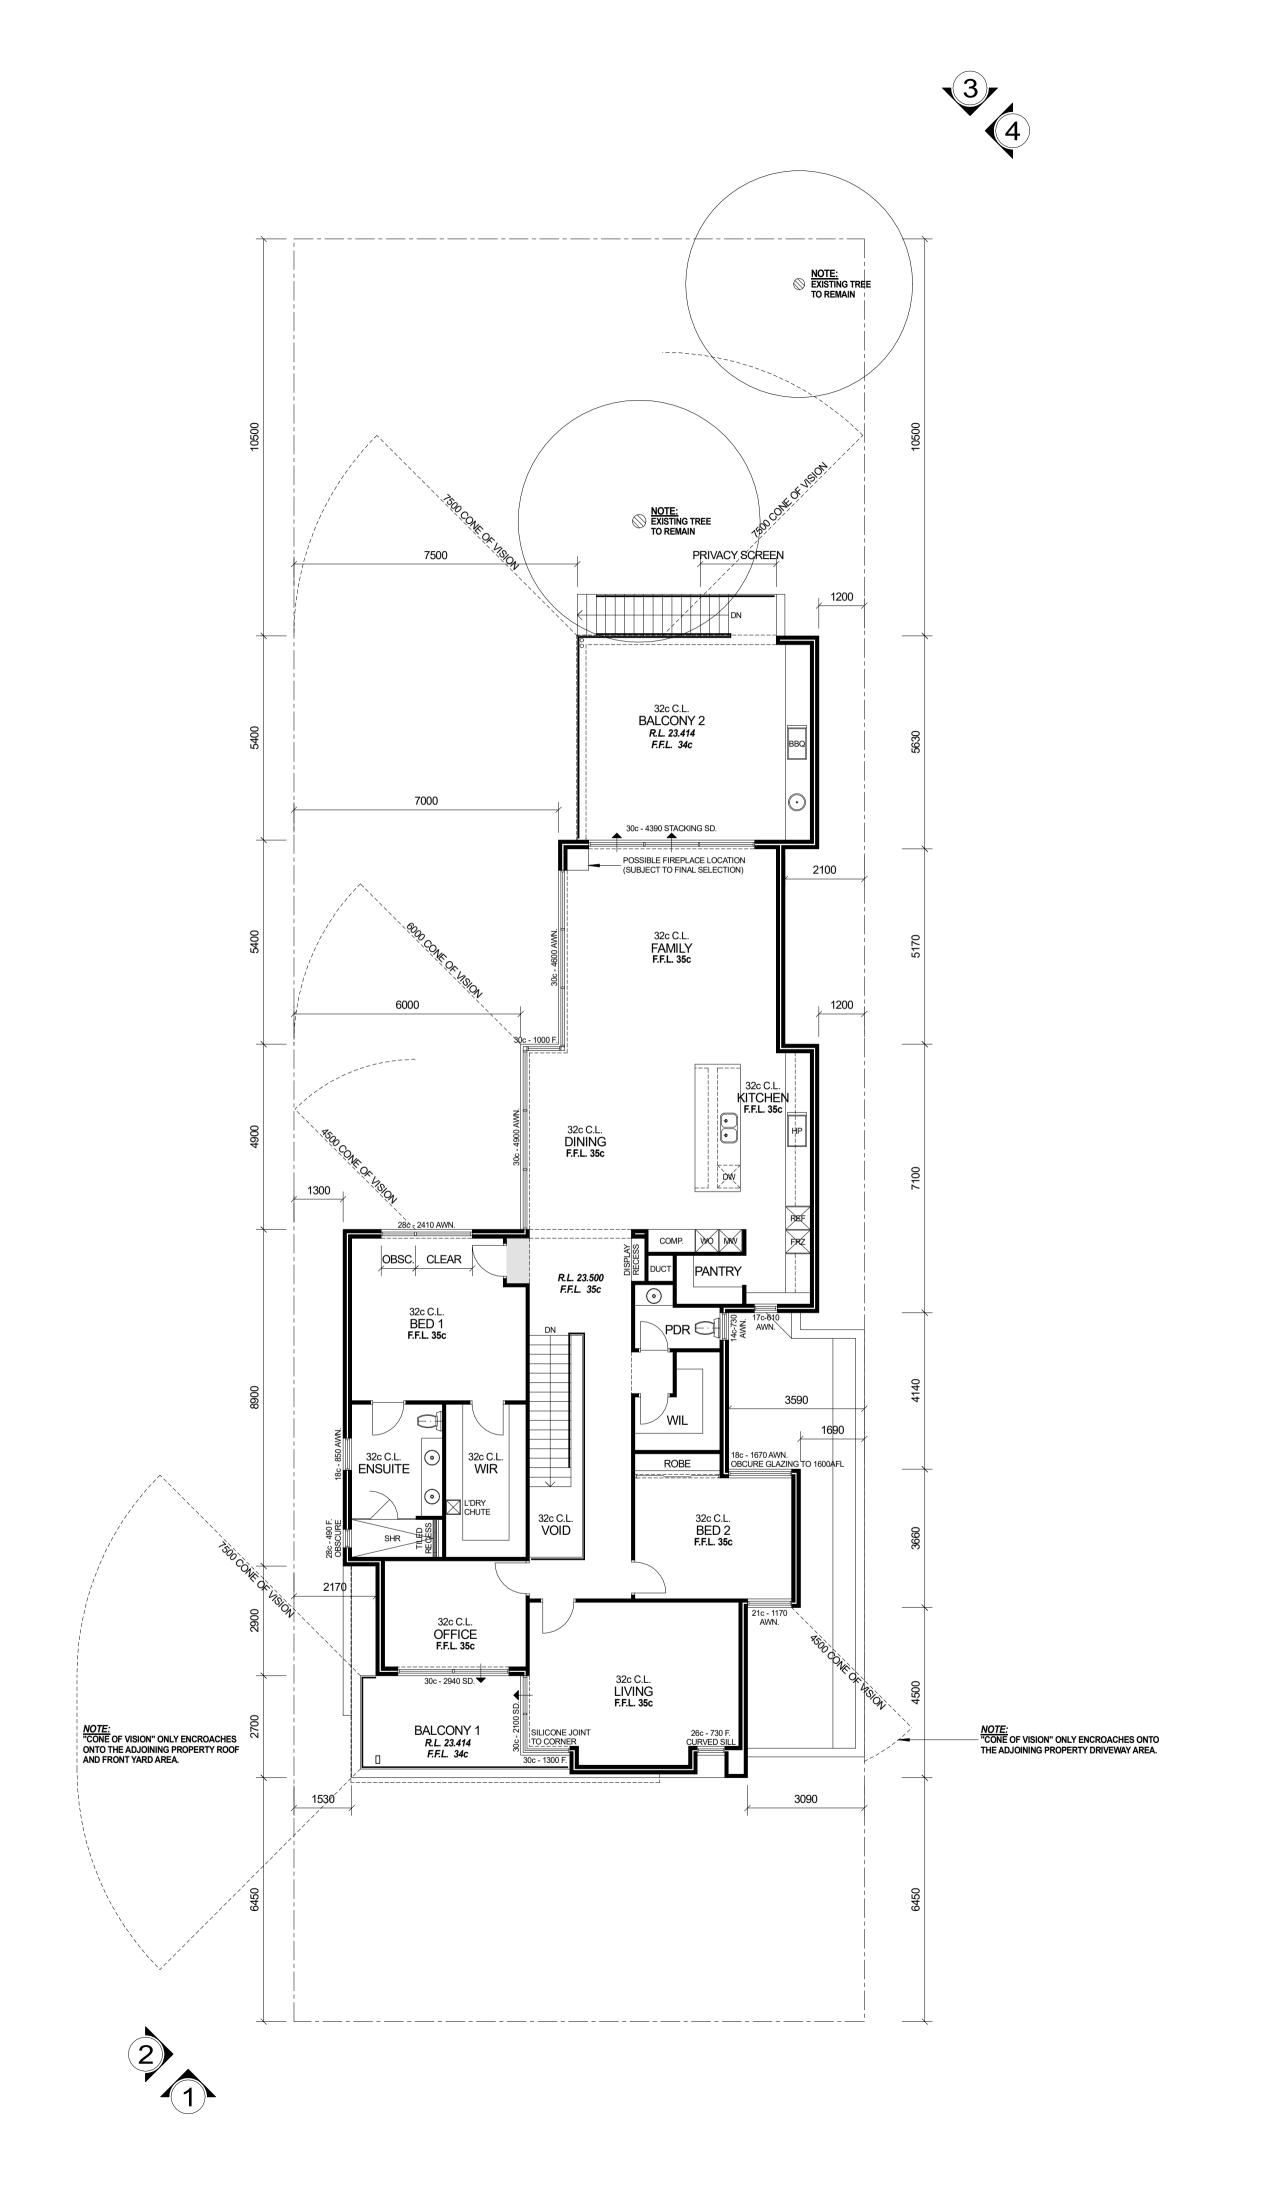



SYMBOL	DESCRIPTION	No. OFF			
R/A	CEILING FRAME NOTE: BOX OUT CEILING JOISTS 1200 x 600 FOR A/C RETURN AIR - PROVIDE UNRESTRICTED ACCESS OVER	0 OFF			
<i>M/H</i>	CEILING FRAME NOTE: 450x450 MAN HOLE INTO ROOF SPACE - PROVIDE UNRESTRICTED ACCESS OVER	0 OFF			
A/C 1	CEILING FRAME NOTE: BOX OUT CEILING JOISTS 1050 x 250 FOR A/C LINEAR VENTS - PROVIDE UNRESTRICTED ACCESS OVER	0 OFF			
W/P 1	BRICKLAYER NOTE: 810 WIDE x 110 HIGH OPENING IN BRICKWORK (FROM 2230 TO 2340 - HEIGHT NOTED ABOVE +06c OFFICE F.L.	0 OFF			
SD	HARD WIRED SMOKE DETECTOR	SEE PLAN			
<b>S.</b> )	SILICONE JOINT TO CORNER WINDOW - MITRED GLASS TO CORNER	SEE PLAN			
NOTE: -ALL EXTERNAL DOORS TO HAVE WEATHER SEALSALL ALUMINIUM WINDOWS TO COMPLY WITH AS 2047CHIMNEY FLUES TO HAVE DAMPERS FITTEDEXHAUST FANS AND RANGEHOODS TO HAVE DAMPERS FITTEDSTAIR CONSTRUCTION TO COMPLY WITH BCA STANDARDS (Part 3.9.1.)SELECTED BALUSTRADE TO COMPLY WITH BCA STANDARDS (Part 3.9.2)NUMBER & POSITION OF DOWNPIPES ARE SUBJECT TO VARIATION BY PLUMBER ON SITETHESE DRAWINGS ARE TO BE READ IN CONJUNCTION WITH STRUCTURAL ENGINEERS DWGSLIFT OFF HINGES ARE TO BE USED TO ALL WC'S TO COMPLY WITH BCA STANDARDS (Part 3.8.3.3)ALL WINDOW OPENINGS TO COMPLY WITH BCA STANDARDS (Part 3.9.2.5).					
NOTE: WIND RATING N APPLIES					
GROUND FLO house: garage: pool terrace: porch:	159.881m² (per. 71.400m) 56.996m²				
Total ground fl	oor: 264.752m²				
1st FLOOR AR house: balcony 1: balcony 2:	EA: 216.241m² (per. 78.380m) 10.473m² 36.352m²				
Total 1st floor	area: 263.066m²				
TOTAL AREA: 527.818m <sup>2</sup>					
<b>FZURE</b>					
Suite 1, 389 Oxford Street Mount Hawthorn WA 6016 W azureluxuryhomes.com.au T (08) 6444 9930					

E nick@ndpdesign.com.au W ndpdesign.com.au M 0414 592 142

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CLIENT: HEUER 1st FLOOR PLAN SCALE 1:100 ADDRESS: LOT 254 (# 19) HIGH STREET,

DRAWN:
NDP
DATE:
SEPT. 2023
SHEET SIZE:
A1

DOB No:
AZ119
AZ119
SHEET 3

SHEET 3

SORRENTO

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