

LOT MISCLOSE 0.003m

⚠DISCLAIMER:

Due to lack of survey marks/pegs, all building offset dimensions & features are approximate only and positioned from existing pegs/fences and walls which may not be on the correct alignment. Any design that involves additions to any structures shown or portion of structures remaining after any demolition has taken place requires boundaries to be repegged and exact offsets provided to your designer/architect before any plans are produced and before any work is started on site.

⚠DISCLAIMER:

Lot boundaries drawn on survey are based on landgate plan only. Survey does not include title search and as such may not show easements or other interests not shown on plan. Title should be checked to verify all lot details and for any easements or other interests which may affect building on the property.

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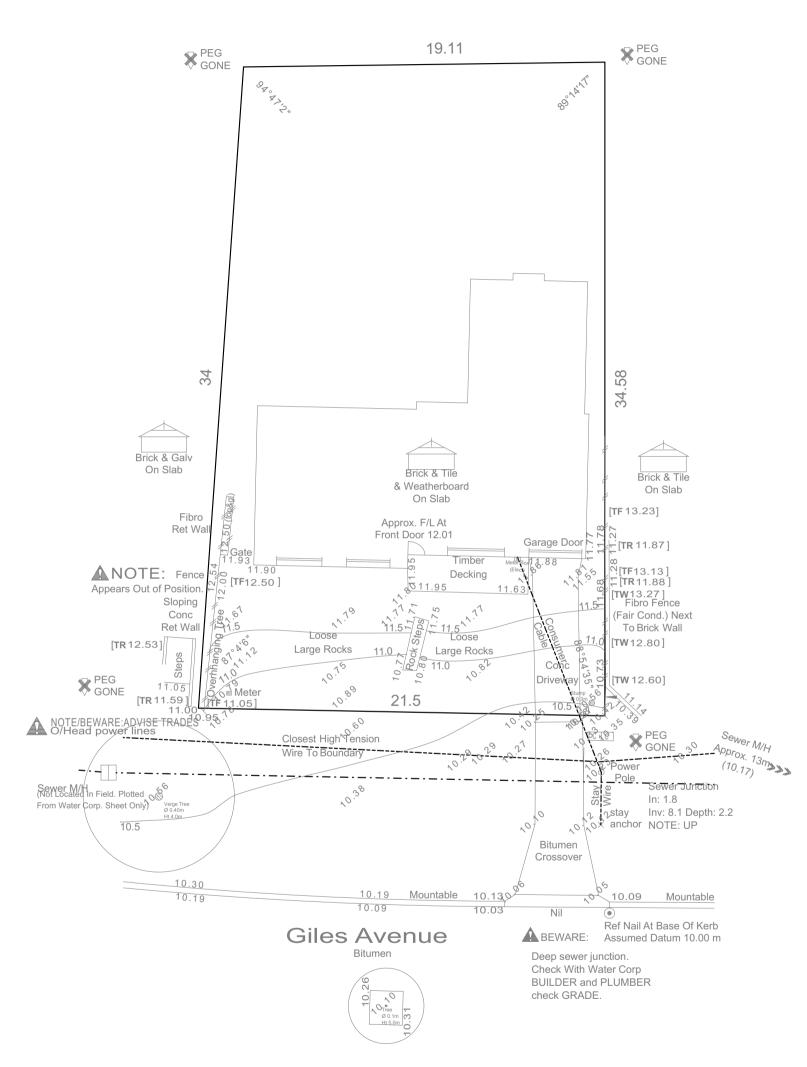
Survey does not include verification of cadastral boundaries. All features and levels shown are based on orientation to existing pegs and fences only which may not be on correct cadastral alignment. Any designs based or dependent on the location of existing features should have those features' location verified in relation to the true boundary.

DISCLAIMER:

Survey shows visible features only and will not show locations of underground pipes or conduits for internal or mains services. Verification of the location of all internal and mains services should be confirmed prior to finalisation of any design work.

⚠DISCLAIMER:

Cottage & Engineering surveys accept no responsibility for any physical on site changes to the parcel or portion of the parcel of land shown on this survey including any adjoining neighbours levels and features that have occurred after the date on this survey. All Sewer details plotted from information supplied by Water Corporation.



▲DISCLAIMER: HIGH TENSION POWER LINES. CHECK TITLE FOR EASEMENTS AND WESTERN POWER FOR SET-BACKS.

EXISTING SITE PLAN

COTTAGE SURVEYS

87-89 Guthrie Street **GPS** Lat: -31.806502 Long: 115.759510 ROADS JOB# ELEC. O/Head 510607 Bitumen Osborne Park, WA 6017 CLIENT **KERBS** COMMS. Yes Rechter, Philip Mountable PO Box 1611 ADDRESS #24 Giles Avenue Lot 336 (Plan 10695) FOOTPATH Nil LOT WATER Yes Osborne Park Business Centre WA 6917SUBURB Padbury SOIL GAS Check Alinta LGA CITY OF JOONDALUP **AREA** DRAINAGE Good SEWER Yes P: (08) 9446 7361 695m² VOL. 1365 FOL.20 E: perth@cottage.com.au DRAWN J. Jee COASTALNo VEGETATIONLight Grass Cover DATE 06 Oct 21 SSA No www.cottage.com.au



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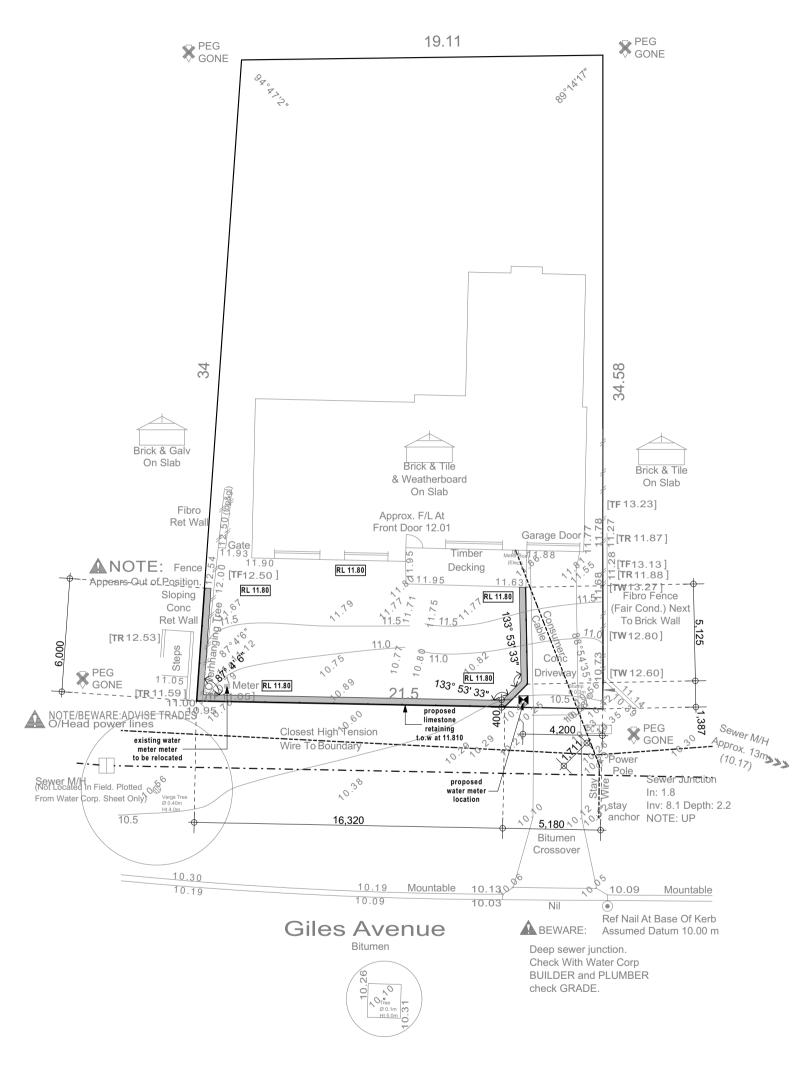
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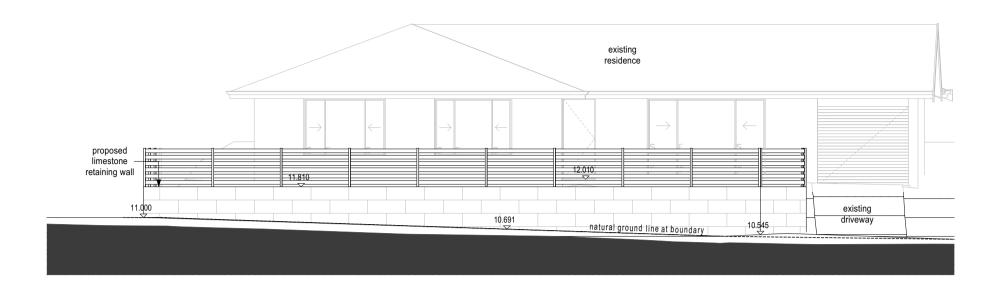
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PROPOSED SITE PLAN

ADISCLAIMER: HIGH TENSION POWER LINES. CHECK TITLE FOR EASEMENTS AND WESTERN POWER FOR SET-BACKS.

24 Giles Avenue PADBURY	e				01/06/2023			SCALE:1:200 JOB NO: 23-06
ADDRESS:					DATE:			2 of 3
E Mumme & J R	lechter							SHEET No.
CLIENT:						AMENDMENTS:		
30 M V L I 3	E: perth@cottage.com.au W: www.cottage.com.au	RAWN J. Jee	DATE	06 Oct 21	SSA No	VEGETATIONLight Grass Cover	COAST	TALNo
Q II D V E V Q	P: (08) 9446 7361 L	GA CITY OF JOONDALUP	AREA	695m² VOL.	1365 FOL.20	DRAINAGE Good	SEWE	R Yes
COTTAGE	Business Centre WA 6917 _S	UBURB Padbury				SOIL Sand	GAS	Check Alinta
	Osborne Park	DDRESS #24 Giles Avenue	LOT	Lot 336 (Plan 106	695)	FOOTPATH Nil	WATER	R Yes
	PO Box 1611	LIENT Rechter, Philip				KERBS Mountable	COMM	IS. Yes
	87-89 Guthrie Street Osborne Park, WA 6017	OB # 510607	GPS	Lat: -31.806502	Long: 115.759510	ROADS Bitumen	ELEC.	O/Head



ELEVATION 1



ELEVATION 2

CLIENT:	AMENDMENTS:	
E Mumme & J Rechter		SHEET No.
ADDRESS:	DATE:	3 of 3
24 Giles Avenue	01/06/2023	SCALE:1:100
PADBURY		JOB NO: 23-06

Item 3: Local planning framework objectives:

"To protect and enhance the natural and built environment within the City."

The below image shows the use of walls along the property boundary by neighbouring properties. This shows that the construction of the retaining is in keeping with the built environment of the city and would improve the continuity between the properties from the street.



 "To provide additional and more diverse housing to cater for an ageing population and changing household structures."

Access to the house has been improved by the addition of limestone stairs leading up to the front door. Previously the house only had uneven rock steps for access that impeded access to the property for some people.

 "Encourage regeneration of older areas to provide opportunities for more diverse housing types and to upgrade physical infrastructure and improve amenity."

The primary purpose of the retaining wall is to upgrade the physical infrastructure. As the house was built on sloping ground over time the foundations of the house have shifted resulting cracks to appear in the walls. It is intended that the retaining wall will help prevent further shifting of the ground and minimise the extent of degradation on the house.

Item 4: Common standard in the area

The below images show relevant examples of retaining walls in the surrounding area that fit a similar design specification of the proposed retaining wall. By considering these retaining walls it is evident that the proposed retaining wall is in keeping with the surrounding area and will not be detrimental to visual aesthetic of the neighbourhood.

70 Giles Ave, Padbury



85 Giles ave, Padbury



73 Giles ave, Padbury



Kind Regards,

Evan Mumme

5/12/2023