

(REFER TO SITE REPORT FOR DETAILS) WIND LOAD - N1
ORROSION CLASSIFICATION - R3 FRAMING NOTE - EXTERNAL WALLS TO BE STEEL FRAME BRICK VENEER **ROOF NOTE**

- <u>COLORBOND</u> ROOF, PITCH AT 25° W/- 500W EAVES UNO - STEEL ROOF FRAME TO NASH STANDARDS - CEILINGS AT 28c + PLATE UNLESS NOTED OTHERWISE ROOF PLUMBER NOTE

- PROVIDE SLOTTED GUTTERS (EXC. GUTTER ON WALLS) - FINAL POSITIONS OF RWP'S TO BE DETERMINED ON SITE - RWP'S IN PORCH TO BE STRAIGHT CONNECTION TO STORMWATER SYSTEM (NO KICK)
- EAVE VENT FOR FLUMING OF NOMINATED EXHAUST FAN, R/HOOD OR CEILING VENT INDICATED ON PLAN BY: IF NOT SHOWN REFER TO ELEVATION FOR ROOF OR

ROOF INSULATION NOTE - R4.0 CEILING INSULATION TO HOUSE, GARAGE & ANY EXTERNAL PLASTERBOARD CEILINGS IF APPL. WALL INSULATION NOTE PROVIDE R2 INSULATION TO ALL FRAMED WALLS **ELECTRICAL NOTE**

- INTERCONNECTED SMOKE DETECTORS TO COMPLY WITH AS3786-2014 AS INDICATED ON PLAN FIXING CARPENTER NOTE - 4 No. 450D SHELVES TO PANTRY AND LINEN UNO - 450D SHELF & RAIL TO ALL WIR, ROBE & ROBE REC. UNO 450D SHELF AT 1700 AFL TO BROOM CUPBOARD, IF ANY CEILING MATERIAL NOTE

REFER TO ADDENDA FOR CEILING / EAVE LINING SELECTION


RENDER WALL NOTE - PROVIDE BATTEN TO JUNCTIONS OF RENDERED WALLS & FIBRE CEMENT CEILINGS


10,590 900 800 1,000 600 7,290 230 1,440 190 1,200 bed 3 robe 3,310 1,000 190 1,640 90 4,010 1,640 230 living / dining wc/ bath 2,710 230 650 1,440 1,90 1,200 690 610 1,000 600 1,190 2,410 1,810 800





PROVIDE FLOOR TILING FROM BUILDERS STANDARD RANGE TO LIVING, DINING, KITCHEN, WIP, ENTRY & BED PASS
PROVIDE CARPET FROM BUILDERS STANDARD RANGE TO ALL BEDROOMS (INC. ROBES) & THEATRE PROVIDE BLINDS THROUGHOUT (EXCLUDING WET AREAS) PROVIDE INTERNAL PAINTING THROUGHOUT

(REFER TO COLOUR SELECTION)

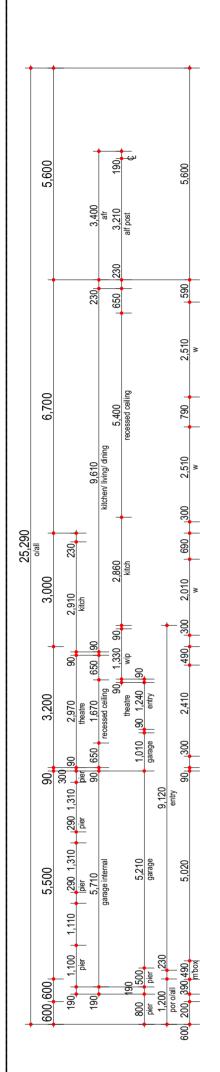

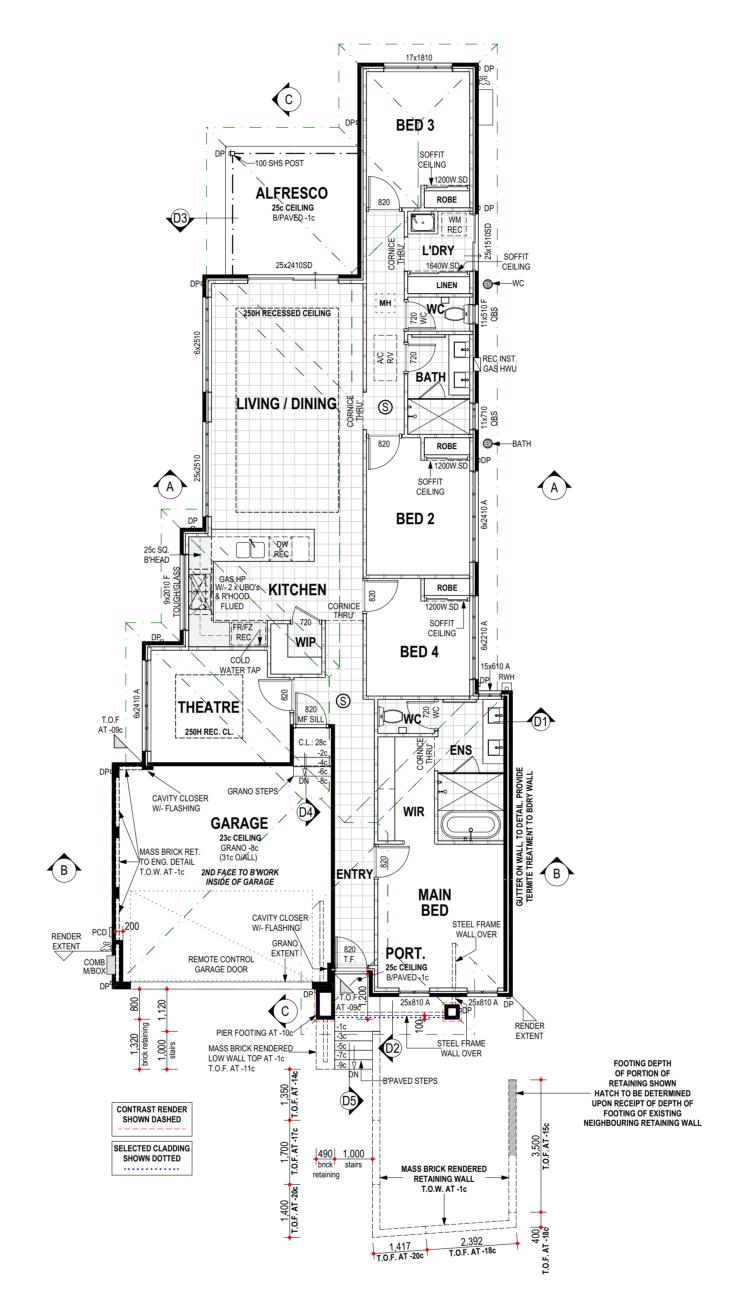

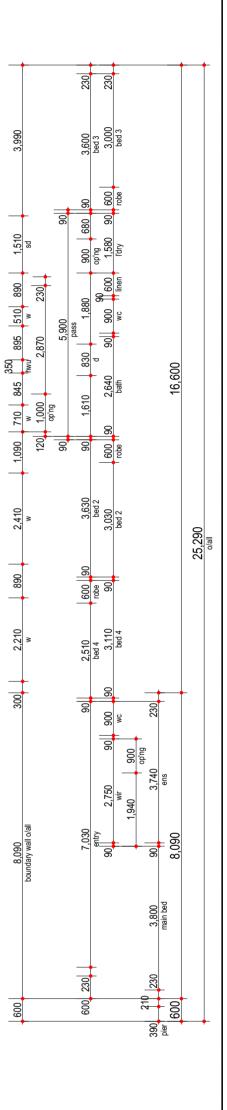

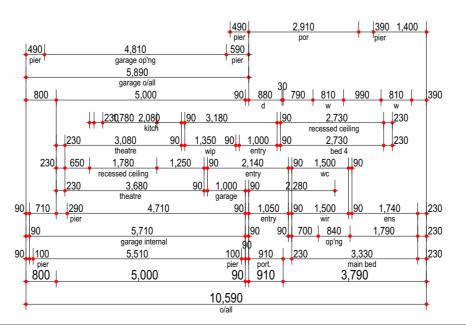



FLOOR PLAN

Area m² Perim 149.03 FLOOR PLAN 70.98 GARAGE ALFRESCO 35.30 11.90 1.65 25.60 13.80 PORTICO 5.43 197.88 m² ROOF 221.32

DO NOT SCALE FROM THIS DRAWING All Sub-contractors to check dimensions & notes prior to initiating works. Any discrepancies to be notified to the Site Supervisor without delay. ALL DIMENSIONS TO BRICKWORK.

GLAZING NOTE

DOOR NOTE

PLUMBER NOTE

GARAGE NOTE

AIRCON NOTE

- PLUMBER TO INSTALL REFLUX VALVE.

AT -3c UNLESS NOTED OTHERWISE

PLASTERBOARD NOTE

- PROVIDE 6.38mm LAM GLAZING THROUGHOUT ENTIRE TRADES / SUPERVISOR NOTE

ENGINEERS DRAWINGS & STANDARD SPECIFICATION.

- NO HOBS TO SHOWERS UNLESS SHOWN OTHERWISE.

- SINGLE LEAF WALL TO GARAGE IS NOT WATERPROOF - FALL GARAGE SLAB 20mm TOWARDS MAIN GARAGE OP'NG

CONCRETOR/BRK LAYER NOTE

- ALL ISOLATED PIERS AND POSTS TO HAVE FOOTINGS

- PROVIDE PLASTERBOARD TO ALL INTERNAL WALLS UNLESS NOTED OTHERWISE

- PROVIDE REVERSE CYCLE AIR CONDITIONING.
- OUTLET POSITIONS TO BE NOMINATED BY SUPPLIER.

- EXTERNAL UNIT NOT TO BE VISIBLE FROM THE STREET

- EXTERNAL UNIT TO BE HUNG FROM BRACKETS FOR DOUBLE BRICK AND BRICK VENEER CONSTRUCTION.

- EXTERNAL UNIT TO BE INSTALLED ON SLAB ON GROUND FOR FULLY FRAMED CONSTRUCTION.

- TOILET DOOR TO COMPLY W/- CLAUSE 3.8.3.3 OF B.C.A VOL. 2 - ALL DOOR & DOOR HARDWARE AS PER ADDENDUM

- REFER TO STRUCTURAL ENGINEERS DETAILS - ALL PLANS TO BE READ IN CONJUNCTION WITH

PROPOSED RESIDENCE FOR: C. BINKS

SCALE: 1:100 DRAWN: CHECKED: TBA SIZE: DATE: 07.09.23 ES MODEL: JOB N° **SIENA**



BUILD | RENOVATE | DEVELO

I OF 8

A2

ROOF NOTE COLORBOND ROOF, PITCH AT 25° W/- 500W EAVES UNO STEEL ROOF IN ACCORDANCE TO NASH STANDARD CEILINGS AT 28c + PLATE UNLESS NOTED OTHERWISE WINDOW SUPPLIER NOTE SHADED WINDOWS INDICATES OBSCURE GLAZING GLAZING DESIGNED & CONSTRUCTED IN ACCORDANCE WITH AS1288 3,590 **CAPPING** COLORBOND ROOF AT 25° PITCH CL 28c+Plate -SPANDREL CL 28c+Plate 29c 28c 25c PELMET 25c RAKING 100 SHS T.O.W. AT NEIGHBOURS PROPOSED RET. 12.60 FL 0c R.L.: 12.30 REMOTE SECTIONAL GARAGE DOOR T.O.W. AT 12.80 PROPOSED T.O.W. AT -11c RET. WALL **ELEVATION 2 ELEVATION 1** N.G.L. AT BOUNDARY -20c MASS BRICK CONTRAST_ RENDERED LOW WALL MASS BRICK CONTRAST RENDERED RETAINING WALL B'PAVED STEPS -SELECTED_ CLADDING 企 (ENS) (KITCHEN) __ (<u>1972mm)</u> _ GARAGE C.L. 25c 100 SHS RENDER EXTENT T.O.W. AT 12.80 T.O.W. AT 12.60 3º _ _ N.G.L._ T.O.W. AT 12.40 PCD BOX 7c _B'PAVED STEPS BEYOND FL 0c R.L.: 12. PROPOSED RET. WALL **ELEVATION 3** -9c T.O.F AT -9c MASS BRICK RETAINING -INTERNALLY TO GARAGE -14c TO ENG. DETAIL SELECTED CLADDING CAPPING-**GUTTER ON WALL, TO DETAIL.** MASS BRICK CONTRAST PROVIDE TERMITE TREATMENT TO BDRY WALL A/C UNIT RENDER RETAINING TO ENG. DETAIL REC INST. GAS HWU R.L. BEHIND-**ELEVATION 4** -18c NEIGHBOURS – PROPOSED RET. DEPTH UNKOWN -T.O.F. TO BE DETERMINED. Date 04.10.2023 PROPOSED RESIDENCE FOR: GCA SCALE: 1:100 DRAWN: DO NOT SCALE FROM THIS DRAWING C. BINKS SHEET: 2 OF 8 DESIGNED: All Sub-contractors to check dimensions **SUMMIT** CHECKED: SIZE: & notes prior to initiating works. DATE: 07.09.23 ES Any discrepancies to be notified to the HOMES GROUP MODEL: SSL 2, (#2A) ALYCON PLACE, Site Supervisor without delay. JOB N° **ELEVATIONS** SIENA ALL DIMENSIONS TO BRICKWORK. KALLAROO 166694 BUILD | RENOVATE | DEVELO BUILT AROUND PEOPLE Copyright © 2023